


- NOTES:
1. PLACE CURB TYPE SEDIMENT BARRIERS ON GENTLY SLOPING STREET SEGMENTS, WHERE WATER CAN POND AND ALLOW SEDIMENT TO SEPARATE FROM RUNOFF.
 2. SANDBAGS, OF EITHER BURLAP OR WOVEN GEOTEXTILE FABRIC, ARE FILLED WITH GRAVEL, LAYERED AND PACKED TIGHTLY.
 3. LEAVE ONE SANDBAG GAP IN THE TOP ROW TO PROVIDE A SPILLWAY FOR OVERFLOW.
 4. INSPECT BARRIERS AND REMOVED SEDIMENT AFTER EACH STORM EVENT. SEDIMENT AND GRAVEL MUST BE REMOVED FROM THE TRAVELED WAY IMMEDIATELY.

CURB INLET SEDIMENT BARRIER


ENGINEERING STANDARDS 2025				
REVISIONS		ENGINEERING DIVISION CITY OF POMPAÑO BEACH	CURB INLET SEDIMENT BARRIER	
BY	DATE			
			DATE: MAY 2022 DWG. NO. 507-1	
			SCALE: N.T.S.	

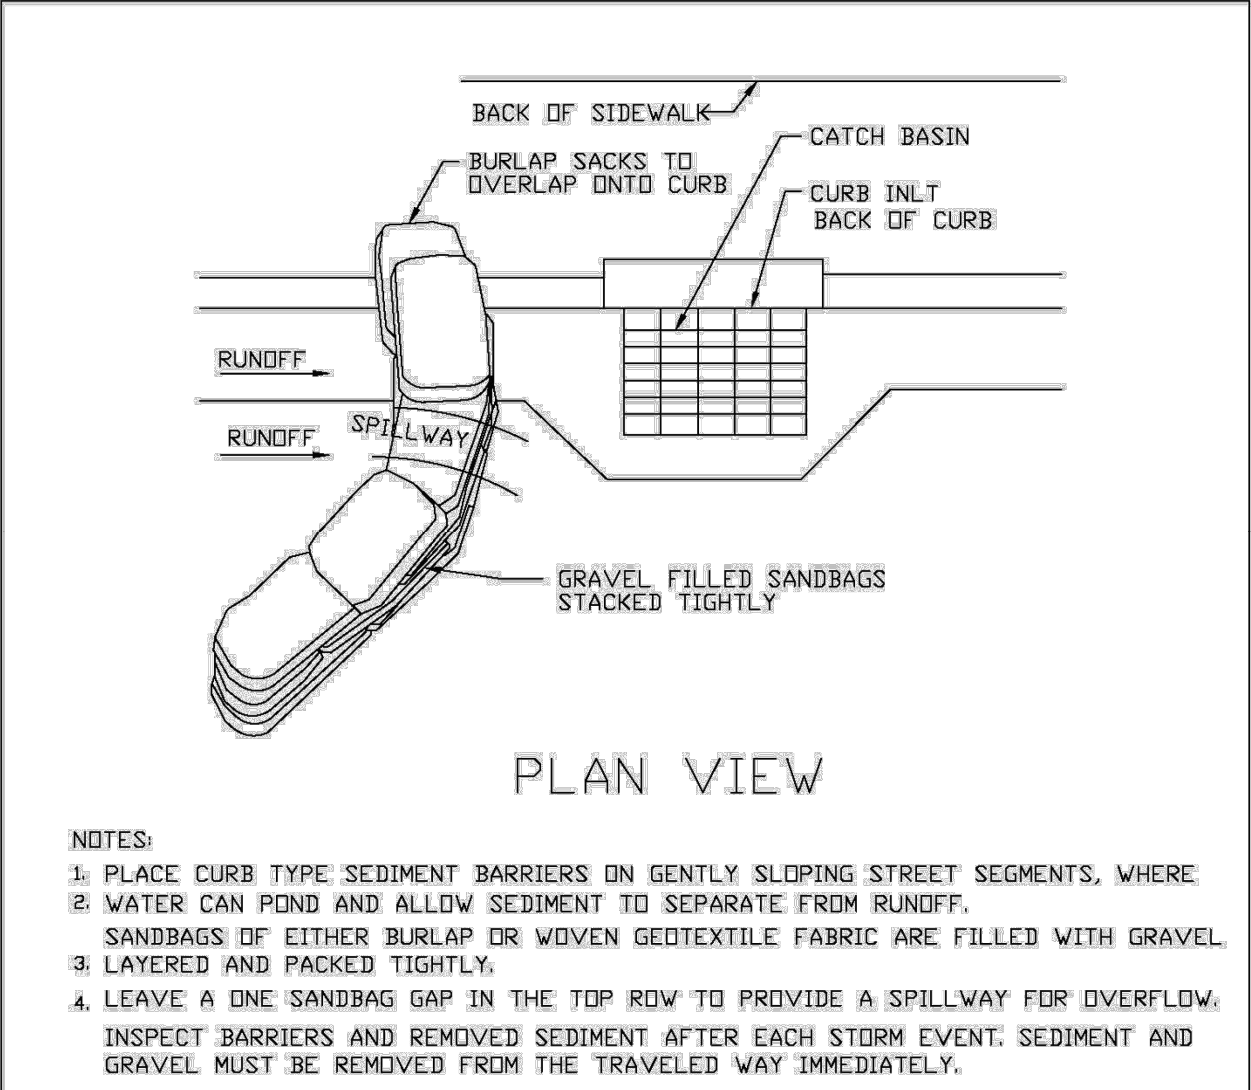

- NOTES:
1. PLACE CURB TYPE SEDIMENT BARRIERS ON GENTLY SLOPING STREET SEGMENTS, WHERE WATER CAN POND AND ALLOW SEDIMENT TO SEPARATE FROM RUNOFF.
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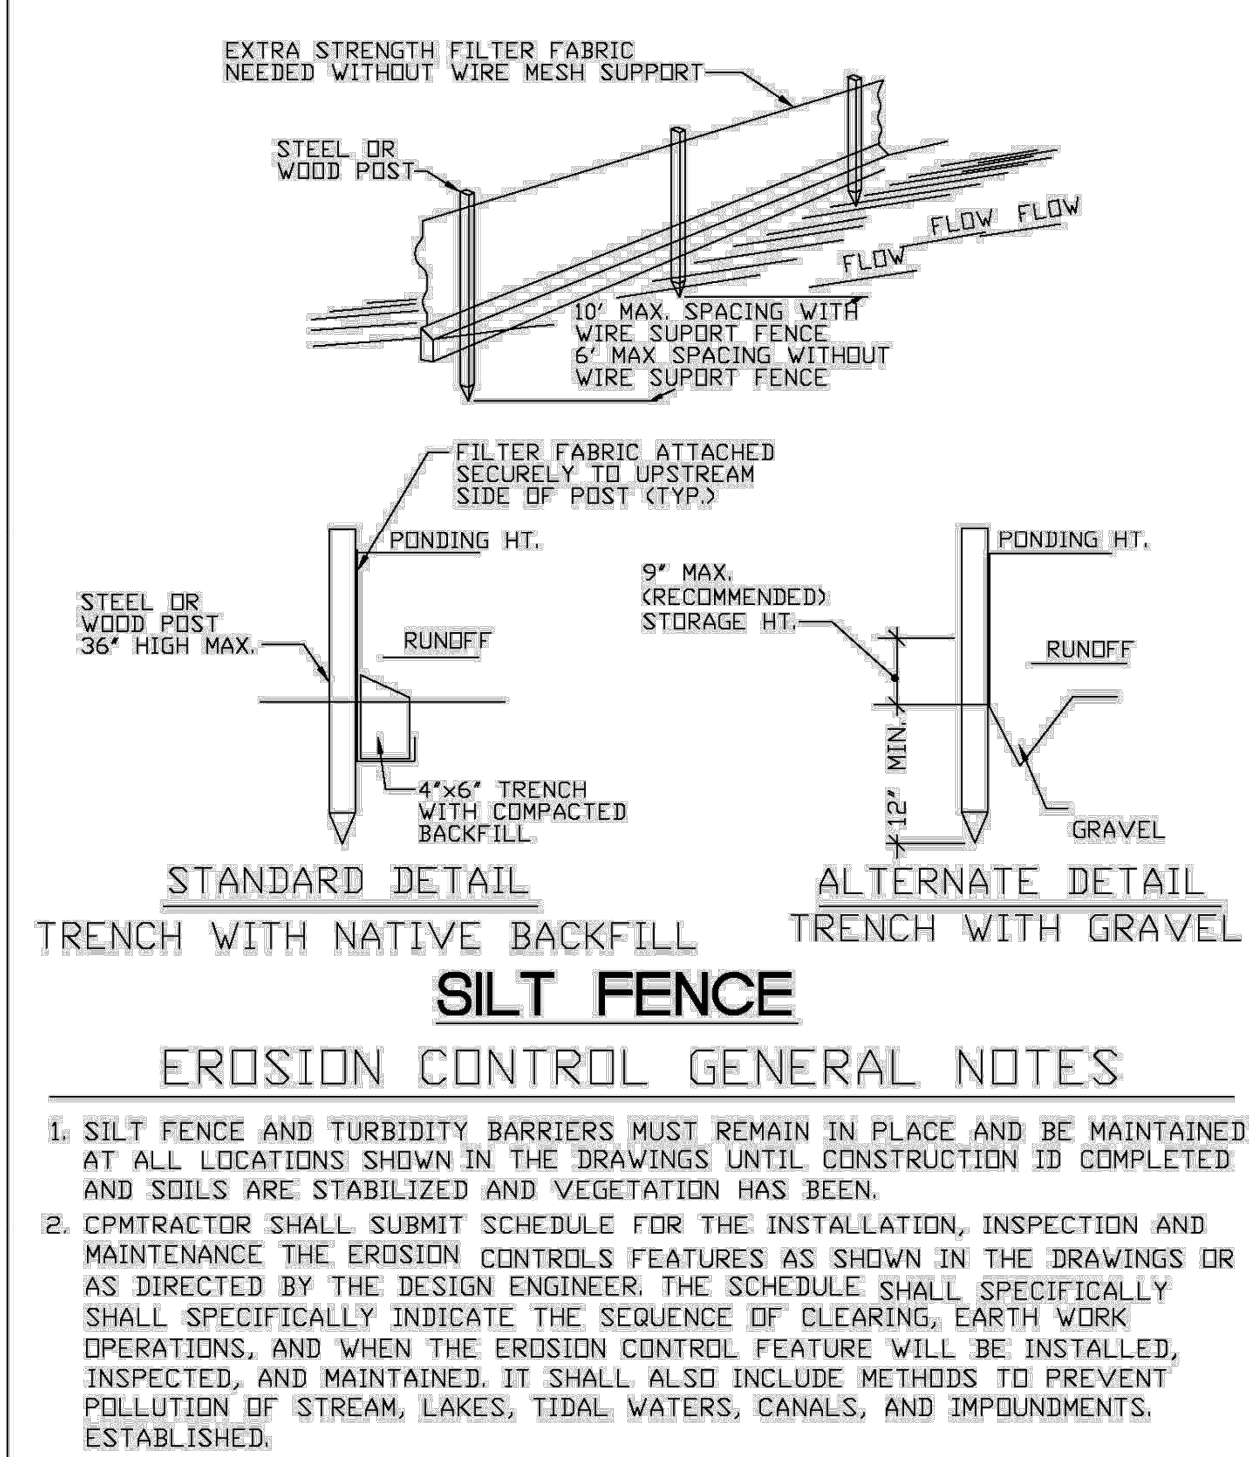
CURB AND GUTTER SEDIMENT BARRIER

ENGINEERING STANDARDS 2025				
REVISIONS		ENGINEERING DIVISION CITY OF POMPAÑO BEACH	CURB AND GUTTER SEDIMENT BARRIER	
BY	DATE			
			DATE: MAY 2022 DWG. NO. 507-2	
			SCALE: N.T.S.	

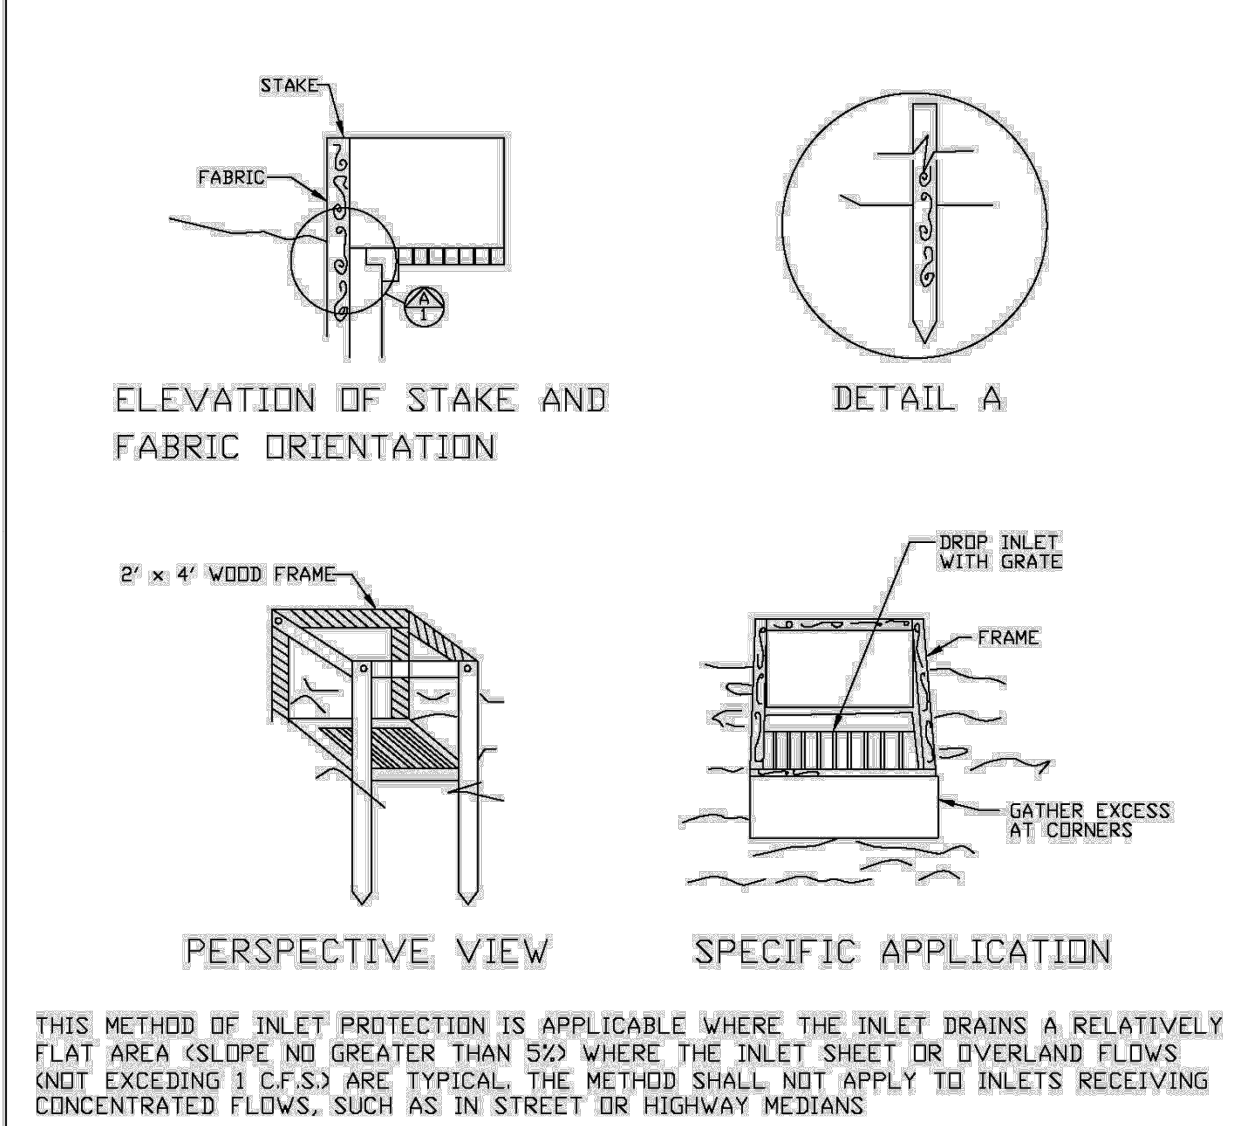


**FILTER FABRIC
DROP INLET SEDIMENT FILTER**

ENGINEERING STANDARDS 2025				
REVISIONS		ENGINEERING DIVISION CITY OF POMPAÑO BEACH	FILTER FABRIC DROP INLET SEDIMENT FILTER	
BY	DATE			
			DATE: MAY 2022 DWG. NO. 508-1	
			SCALE: N.T.S.	



1. SILT FENCE AND TURBIDITY BARRIERS MUST REMAIN IN PLACE AND BE MAINTAINED AT ALL LOCATIONS SHOWN IN THE DRAWINGS UNTIL CONSTRUCTION IS COMPLETED AND SOILS ARE STABILIZED AND VEGETATION HAS BEEN.
2. CONTRACTOR SHALL SUBMIT SCHEDULE FOR THE INSTALLATION, INSPECTION AND MAINTENANCE THE EROSION CONTROLS FEATURES AS SHOWN IN THE DRAWINGS OR AS DIRECTED BY THE DESIGN ENGINEER. THE SCHEDULE SHALL SPECIFICALLY INDICATE THE SEQUENCE OF CLEARING, EARTH WORK OPERATIONS, AND WHEN THE EROSION CONTROL FEATURE WILL BE INSTALLED, INSPECTED, AND MAINTAINED. IT SHALL ALSO INCLUDE METHODS TO PREVENT POLLUTION OF STREAM, LAKES, TIDAL WATERS, CANALS, AND IMPOUNDMENTS ESTABLISHED.

ENGINEERING STANDARDS 2025				
REVISIONS		ENGINEERING DIVISION CITY OF POMPAÑO BEACH	SILT FENCE	
BY	DATE			
			DATE: MAY 2022 DWG. NO. 509-1	
			SCALE: N.T.S.	

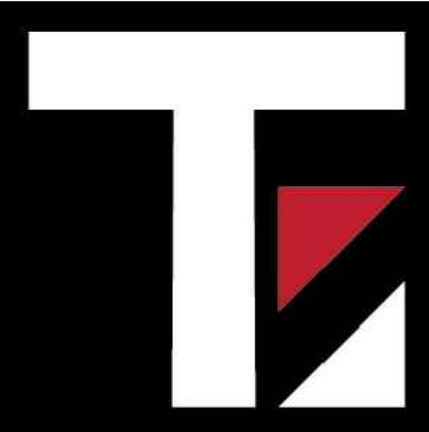

Thompson Engineering
& Consulting, Inc.
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Pembroke Pines, FL 33029
Florida Registry No. 33359
thompson-ec.com
(954) 232-2281

Date: 07/16/2025

This item has been digitally signed and sealed by Justin Thompson, PE, on the date adjacent to the seal.

Printed copies of this document are not considered signed and sealed and the signature must be verified on any electronic copies.

DRC SUBMITTAL
RISING TIDE
CAR WASH
2901 W. ATLANTIC BOULEVARD
POMPAÑO BEACH, FL 33069
CITY OF POMPAÑO BEACH BROWARD COUNTY

Project No.	25-032
Date	07/16/2025
Scale	As Shown
Drawn By	UCS
Checked By	JT

Revisions		
No.	Description	Date

STORM WATER
POLLUTION &
PROTECTION
NOTES & DETAILS

Sheet Number:
C107
Sheet 7 of 18

DRC

PZ25-12000026

08/20/2025